

KEY: FLOOR PLAN


(6)	Architectural Note
XTR	Existing To Remain
(23)	Door Tag
(4)	Window Tag
---	Extent Of Repairing & Patching
(13)	New or Reinstalled Door & Frame See Door Schedules
---	Existing door and frame to remain
---	See Demolition Plans

ARCHITECTURAL NOTES


- 1) CMU infill. Patch around opening & prepare cmu surface to match adjacent.
- 2) Sill stud & gyp bd. infill. Patch around opening & prepare surface to match adjacent.
- 3) Patch around opening & prepare surface to match adjacent.

GENERAL NOTES

- All dimensions are shown to face of stud unless noted otherwise.
- New partitions to extend min. 6" above ceiling, unless noted otherwise.
- See Structural Framing, HVAC, & Electrical Plans for other work.
- See Reflected Ceiling Plan for soffits & bulkheads this floor.

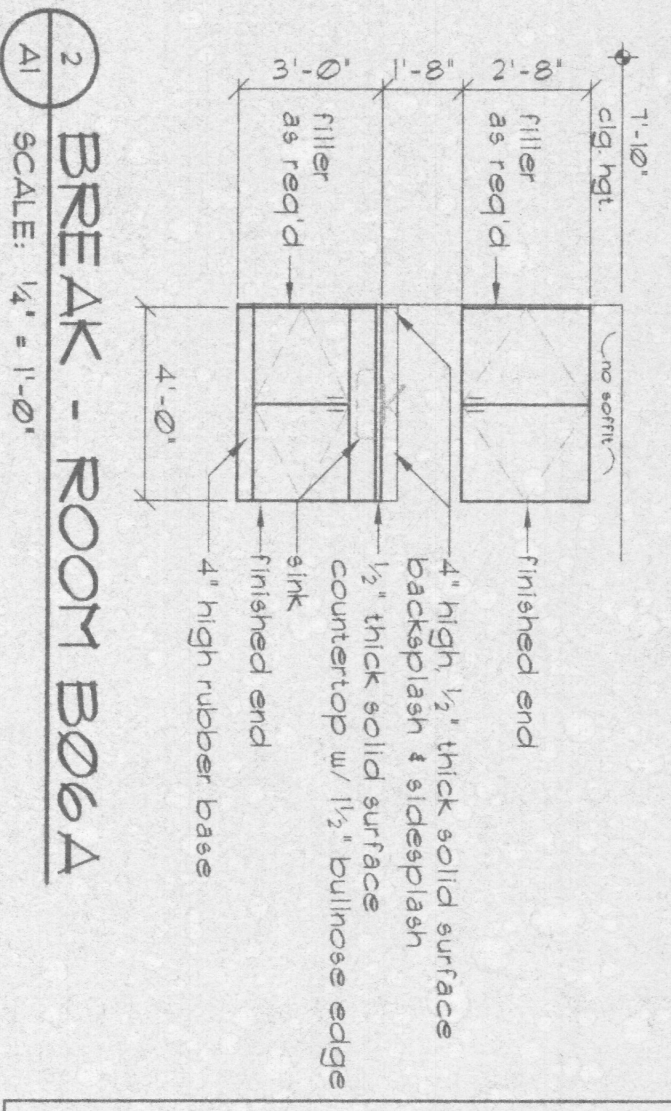

BASEMENT FLOOR PLAN
SCALE: 1/8" = 1'-0"

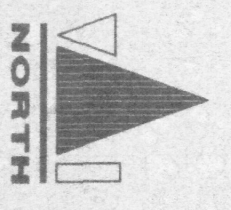

PARTITION TYPES
SCALE: 1/4" = 1'-0"

<p>1 STL. STUD PARTITION Notes: Use 6" studs where noted</p> <p>(1) layer 3/4" gypsum board each side 3/8" steel studs @ 16" OC</p>	<p>2 NOT USED</p> <p>4 layers 1/2" gyp. bd. each side panels vert. or horiz. applied & screw attached, joints staggered & finished, perimeter caulked.</p>
<p>3 UL DESIGN NO. U465 1 HOUR FIRE RATING</p> <p>(1) layer 3/4" gyp. bd. each side panels vert. or horiz. applied & screw attached, joints staggered & finished, perimeter caulked. 3/8" steel studs @ 16" OC</p>	<p>4 UL DESIGN NO. U435 4 HOUR FIRE RATING</p> <p>(1) layer 3/4" gyp. bd. each side 3/8" steel studs @ 16" OC. 1/2" all channel shipped studs @ 1'-4" OC.</p>
<p>5 UL DESIGN NO. U454 STC RATING = 60</p> <p>(2) layer 1/2" FIRECODE gyp. bd. panels applied vert. w/ jts. staggered, perimeter caulked, joints finished RC-1 channel one side spaced @ 2'-0" o.c., screws attached to studs 3" urea sound attenuation fire blankets</p>	<p>6 PLUMBING CHASE</p> <p>7 NOT USED</p> <p>8 PLUMBING CHASE Clear dimension shall be 1'-0"</p> <p>9 NOT USED</p> <p>10 SOUND CONTROL STC RATING = 51</p> <p>(1) layer 3/4" FIRECODE gyp. bd. each side panels vert. or horiz. applied & screw attached, joints staggered & finished, perimeter caulked. 3" urea sound attenuation fire blankets, created to fit cavity. 3/8" steel studs @ 24" OC</p>

BASEMENT FLOOR PLAN

SAUK COUNTY BUILDINGS
BARABOO, WI

COURTHOUSE REMODELING

VERBICHER

FIELD BOOK FILE NO.
JOB NO. 134625300 T004
SHEET 13 of 76 DWG. NO. AI

DATE: 11/11/95 SCALE: As Noted

NO. DATE REVISIONS REMARKS